TP-00252

NOAA FORM 76-35

U.S. DEPARTMENT OF COMMERCE
NATIONAL OCEANIC AND ATMOSPHERIC ADMINISTRATION
NATIONAL OCEAN SURVEY

DESCRIPTIVE REPORT

Job NoCM-77	07	pping Map No. IP+Q0252 Edition No
	LOCALIT	·Y
State New Jers	sey	
General Locality	Delawar	e River
Locality Alloway.	Creek.to.	Salem.River
• • • • • • • • • • • • • • • • • • • •		
		: :
19	75 TO	19
REGIS	TRY IN AF	
Mark more		

☆ U.S. GOVERNMENT PRINTING OFFICE: 1974-762-901

SUMMARY CM-7707 MAPS TP-00246 THRU TP-00256

This summary covers the remaining eleven maps in this project as indicated above. Field edit for these maps was canceled November 16, 1978. They are final reviewed and registered as Class III.

This area was originally scheduled for landmark and aid location under CM-7508. The job was completed in March 1977. All the information obtained for that project was applied to the compiled maps in CM-7707. The forms 76-40 for landmarks and aids is part of each Descriptive Report. However, they are not furnished to charts with this project. Duplicate forms were furnished with job CM-7508 in April 1977.

The purpose of this project is to furnish a base for new hydrographic surveys and nautical chart updating.

The manuscripts were compiled using the Wild B-8 Stereoplotter with 1:20,000 natural color photography taken in 1975.

It was decided to use the New Jersey State Plane Grid as the major grid in this portion of the project except for TP-00249, TP-00251, TP-00253, and TP-00255 which has the Delaware State Plane Grid as the secondary grid.

Final Review was done in the Rockville, Maryland Office in July and August 1979. Neither the bridging nor compilation photography was available at the time of final review.

NOAA FORM 76-36A U. S. DEPARTMENT OF COMMERCE	TYPE OF SURVEY	SURVEY TP-00252
(3-72) NATIONAL OCEANIC AND ATMOSPHERIC ADMIN.		1
	M ORIGINAL	
DESCRIPTIVE REPORT - DATA RECORD	RESURVEY	MAP CLASS III
	REVISED	лов Рн - <u>СМ-7707</u>
PHOTOGRAMMETRIC OFFICE	LAST PRECEED	ING MAP EDITION
Photogrammetry Division Rockville, Maryland	TYPE OF SURVEY	JOB PH
OFFICER-IN-CHARGE	ORIGINAL	MAP CLASS
Cdr. James Collins	RESURVEY	SURVEY DATES:
Cur. dames corrins	REVISED	19TO 19
I. INSTRUCTIONS DATED		
1, OFFICE		FIELD
Instructions-AEROTRIANGULATION (CM-7508) 2/4/76		D (CM-7508) 3/4/75
	Instructions-FIEL	
Instructions-OFFICE-CM-7707 3/18/77	Supplement I 7/	11//5
	<u>:</u>	<u> </u>
II. DATUMS	OTHER (Specify)	· · · · · · · · · · · · · · · · · · ·
1. HORIZONTAL: Y 1927 NORTH AMERICAN		
MEAN HIGH-WATER	OTHER (Specify)	
2. VERTICAL:	National Geodeti	c Vertical
MEAN LOWER LOW-WATER MEAN SEA LEVEL	Datum of 1929	
3. MAP PROJECTION	4.	GR(D(S)
Transverse Mercator Projection	New Jersey	ZONE
1:10,000	STATE	ZONE
III. HISTORY OF OFFICE OPERATIONS	<u> </u>	
OPERATIONS	NAME	DATE
1. AEROTRIANGULATION BY	R. Kelly	10/15/76
METHOD: Analytic LANDMARKS AND AIDS BY	D. Norman	10/15/76
2. CONTROL AND BRIDGE POINTS PLOTTED BY METHOD: COradomat CHECKED BY	V. Connolly NA	7/18/78
3. STEREOSCOPIC INSTRUMENT PLANIMETRY BY	L. Harrod	10/28/78
COMPLATION CHECKED BY	B. Baldwin	10/28/78
INSTRUMENT: Wild By8 CONTOURS BY	<u>NA</u>	
scale: 1:10,000 CHECKED BY 4. MANUSCRIPT DELINEATION PLANIMETRY BY	NA L. Harrod	11/1/78
CHECKED BY	B, Baldwin	11/2/78
метнор: Smooth Drafting contours by	NA	
CHECKED BY	NA	
SCALE: 1:10,000 HYDRO SUPPORT DATA BY	NA NA	
CHECKED BY 5, OFFICE INSPECTION PRIOR TO FIELD EDIT BY	NA NA	
ВУ	Field Edit Cancel	ed 11/16/78
6. APPLICATION OF FIELD EDIT DATA CHECKED BY		
7. COMPILATION SECTION REVIEW BY	G. Fromm	3/13/79
8. FINAL REVIEW BY	F.R. Watts	8/13/79 4/9/79
9. DATA FORWARDED TO PHOTOGRAMMETRIC BRANCH BY 10. DATA EXAMINED IN PHOTOGRAMMETRIC BRANCH BY	G. Fromm F. R. Watts	8/13/79
11. MAP REGISTERED - COASTAL SURVEY SECTION BY	EL DAUGHERTY	NOV 1979

NOAA FORM 76-36B (3-72)	4,		NATIONAL OCEAN	IC AND ATMOSPHERIC	IT OF COMMERCE ADMINISTRATION _ OCEAN SURVEY
	CON	PILATION SOL	IRCES TP-	00252	L OCEAN SURVEY
1. COMPILATION PHOTOGRAPH	Y				<u></u>
CAMERA(S) Wild RC-10 (E 352.7 mm focal leng	3) & RC-8(E)		HOTOGRAPHY END	TIME REFE	RENCE
TIDE STAGE REFERENCE		(C) COLOR		zone Eastern	Xstandard
REFERENCE STATION RECO	RĎS	(P) PANCHROI		MERIDIAN	-
TIDE CONTROLLED PHOTOG	RAPHY	(I) INFRARED	•	75th	DAYLIGHT
NUMBER AND TYPE	DATE	TIME	SCALE	STAGE OF	TIDE
75 E(C) 8747-8749	1237-1243	4/9/75	1:20,000	+3.22 Ft. MLW	1
75 B(C) 4732-4736	848-853	8/28/75	1:20,000	+.70 Ft. MLW	
	i '			į	
REMARKS			10.000 3		
the above ph	otography was i	ratioed to I	:10,000 scal	e.	
2. SOURCE OF MEAN HIGH-WAT	ER LINE:		_		
The source o	of the mean high	n water line	is the phot	ography listed	
		•			
under Item I	•				
3. SOURCE OF MEAN LOW-WAT	ER OR MEAN LOWER LO	W-WATER LINE:			
No mean low	water was depic	ted on this	map.		
4. CONTEMPORARY HYDROGRA	APHIC SURVEYS (List of	nly those surveys t	hat are sources for	photogrammetric survey i	n formation.)
SURVEY NUMBER DATE(S)	SURVEY COR	Y USED SURV	EY NUMBER D	ATE(S) SURVE	EY COPY USED
			<u> </u>		
5. FINAL JUNCTIONS NORTH	EAST NO	SOUT		WEST	
TP-00250	Contemporary S	Survey TP-	00253 & TP-0	0254 TP=0	00251
REMARKS			<u>-</u> -		


NOAA FORM 76-36C (3-72)		NATIONAL OCEA!	NIC AND ATMOSPHER	MENT OF COMMERC IC Administrational ocean surve
	HISTORY OF FIELD	OPERATIONS	TP-00252	
I. 💢 FIELD INSPECTION	OPERATION FIEL	D EDIT OPERATION		
	OPERATION	N	AME	DATE
1. CHIEF OF FIELD PART	Υ	R.S. Tibbett	s	1975-1976
	RECOVERED BY	R.S. Tibbett	S .	March 1975
. HORIZONTAL CONTROI		R.S. Tibbett		March 1975
	PRE-MARKED OR IDENTIFIED BY	R.S. Tibbett		March 1975
	RECOVERED BY	NA _		
. VERTICAL CONTROL	ESTABLISHED BY	NA	· •	
	PRE-MARKED OR IDENTIFIED BY	NA		
	RECOVERED (Triangulation Stations) BY	NA		
LANDMARKS AND	LOCATED (Field Methods) BY	R.S.Tibbetts		7/17/75
AIDS TO NAVIGATION	IDENTIFIED BY	R.S. Tibbett	S	7/17/75
	TYPE OF INVESTIGATION			
. GEOGRAPHIC NAMES	COMPLETE BY			
INVESTIGATION	SPECIFIC NAMES ONLY			
	X NO INVESTIGATION	NA NA		
PHOTO INSPECTION	CLARIFICATION OF DETAILS BY	NA		
BOUNDARIES AND LIMI	TS SURVEYED OR IDENTIFIED BY	NA		
SOURCE DATA		Ta	T	
. HORIZONTAL CONTRO	LIDENTIFIED	2. VERTICAL CON	I ROL IDENTIFIED	
PHOTO NUMBER	STATION NAME	PHOTO NUMBER	STATION DE	SIGNATION
	field operations were perfor	med under Job	- CM-/508	
3. PHOTO NUMBERS (Clar.				
	TO NAVIGATION IDENTIFIED 76-40 listing bound with th	is Descriptiv	e Renort	
PHOTO NUMBER	OBJECT NAME	PHOTO NUMBER	OBJECT	- NAME
	OBJECT HAME	PHOTO NUMBER		NAME
5. GEOGRAPHIC NAMES:	REPORT K NONE	6. BOUNDARY AND	LIMITS: REPO	ORT X NONE
. SUPPLEMENTAL MAPS	AND PLANS			
None OTHER FIELD RECORD	S (Sketch books, etc. DO NOT list data submit	ted to the Gardasy Di	vision)	
	records are on file under J	•	*14/01/)	
ALL LIETU	records are on the angel of	OD 60177 300		

U. S. DEPARTMENT OF COMMERCE NATIONAL OCEANIC AND ATMOSPHERIC ADMINISTRATION

RECORD OF SURVEY USE

TP-00252

I. MANUSC	RIPT COPIES								
	Со	MPILATION STAGE		100	DATE MANUSCRIPT FORWARDED				
	DATA COMPILED	DATE		REMARKS		MARINE CHARTS	HYDRO SUPPOR		
	ation Section complete	3/13/79	Class Field	III Map Edit cance	led				
	Reviewed to registration	8/13/79	Class Field	III Map Edit cance	led	10/3/19			
	ARKS AND AIDS TO NAVIGA		DATA BRAN	CH					
I. REP	CHART LETTER	DATE	DATA BRAN	СП					
NUMBER	NUMBER ASSIGNED	FORWARDED			REMA				
3.	REPORT TO MARINE CHAR REPORT TO AERONAUTICA RAL RECORDS CENTER DA'	L CHART DIVISION							
2. 🖂	BRIDGING PHOTOGRAPHS; CONTROL STATION IDENT SOURCE DATA (except for C ACCOUNT FOR EXCEPTION DATA TO FEDERAL RECO	IFICATION CARDS; Geographic Names Re	FORM	NOS 567 SUBMI	TTED BY	FIELD PARTIES.			
IV. SURVI	EY EDITIONS (This section	shall be completed e	ach time a new	map edition is r	egistered)				
	SURVEY NUMBER	(2) PH -	R			YPE OF SURVEY			
SECOND	DATE OF PHOTOGRAP		IELD EDIT		- KEV	MAP CLASS	SURVEY		
EDITION	and a state of the	53,257		□11.	□m.	DIV. DV.	FINAL		
	SURVEY NUMBER	JOB NUMBE	R		Ť	YPE OF SURVEY			
THIRD		_ (3) PH				SED RE	SURVEY		
EDITION	DATE OF PHOTOGRAP	HY DATE OF F	IELD EDIT	□··.		MAP CLASS	TEINA!		
	SURVEY NUMBER	JOB NUMBE	R			YPE OF SURVEY			
FOURTH	TP	_ (4) PH				ISED RES			
EDITION	DATE OF PHOTOGRAP		SCHOOL STATE OF THE STATE OF TH			MAP CLASS			
				□n.	□ III.	□iv. □v.	FINAL		

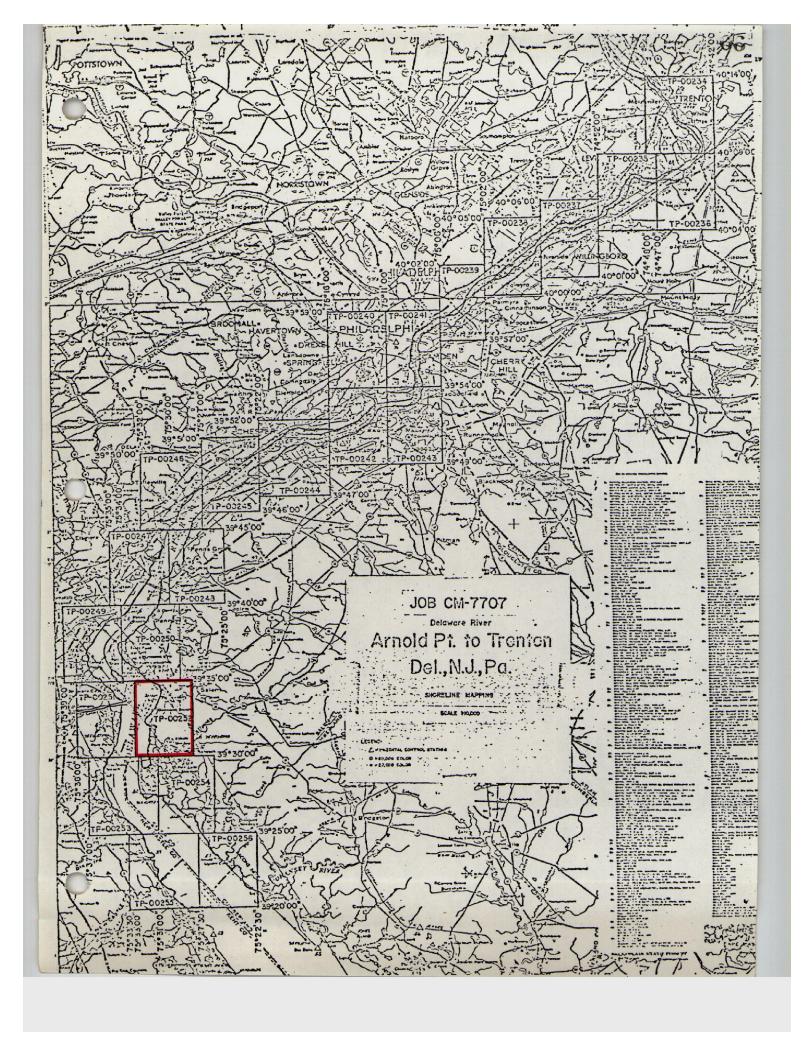

FIELD INSPECTION

There was no field inspection performed under Job CM-7707. Field work prior to compilation was accomplished under Job CM-7508. This field work consisted of the recovery and identification of horizontal control and the locating or photoidentifying of landmarks, non-floating aids, and supplement objects.

Photogrammetric Plot Report
Delaware River
Arnold Pt. to Trenton, New Jersey
CM-7707
November 17, 1977

Project CM-7707 is a continuation of CM-7508. Briefly, in CM-7508, positions of landmarks, aids to navigation, and supplemental objects were determind by photogrammetric methods. In CM-7707, shoreline maps are to be compiled. The photography and control are the same for both projects. Additional photos were bridged for CM-7707 to give complete shoreline coverage.

21. Area Covered

The area covered is the Delaware River from Arnold Point, near the mouth of the Cohansey River to Trenton, New Jersey. This area is covered by 23 1:10,000 scale sheets. They are numbered TP-00234 thru TP-00256.

22. Method

Twenty strips of photography were bridged by analytic aerotriangulation methods and adjusted to ground on the New Jersey State Plane Coordinate system. Four strips of 1:60,000 scale photography were bridged to control sixteen strips of 1:20,000 scale photography. (see attached aerotriangulation sketch for photos).

23. Adequacy of Control

The horizontal control was adequate. However, the panel for Navy, 1925 would not fit in the adjustment. No reason could be determined and the station was dropped from the adjustment.

24. Supplemental Data

USGS tropographic quadrangles were used to provide vertical control requirements for strip adjustments.

25. Photography

The photography was adequate.


Submitted by,

Don O. Norma

Don O. Norman


Approved and forwarded:

John D. Perrow, Jr., Chief, Aerotriangulation Section

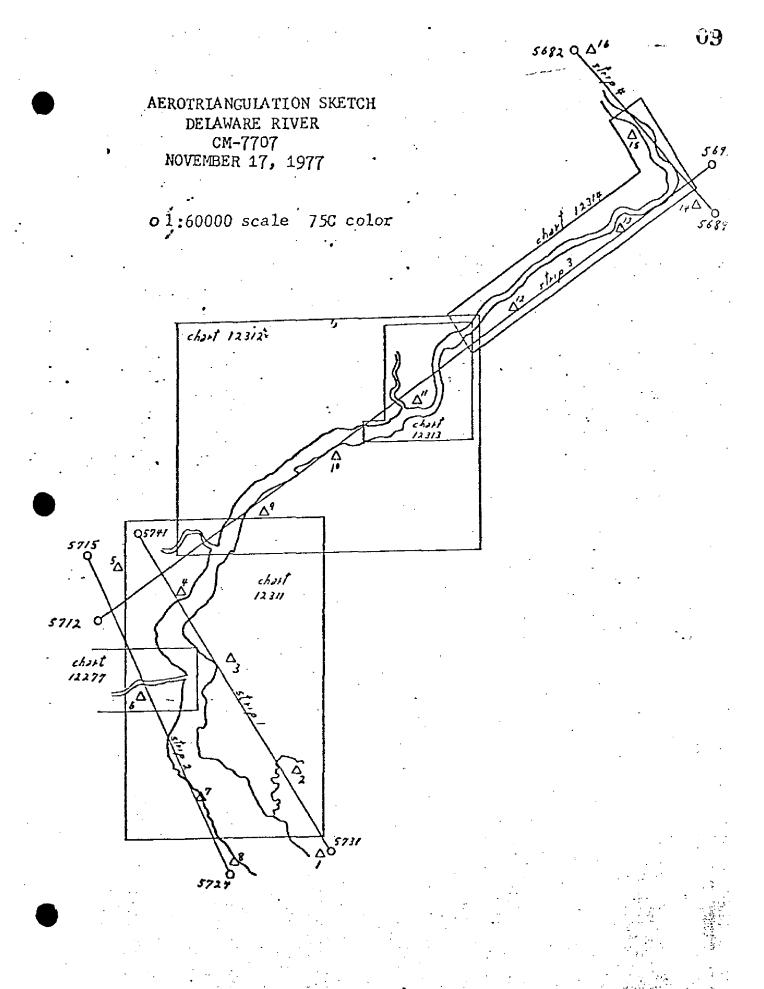

fit to control (feet)

strip 1		
1 WELLS,1975 , 2 WILLIS, 1933	(0.5,	0.3)
, 2 WILLIS, 1933	(0.6,	0.5)
3 SALEM, 1933	(0.9,	1.5)
4 NEW CASTLE BELLANCA AIRPORT		•
SQUAT W.T., 1933	(0.2,	4.5)
5 CHRIS 2, 1962	(0.8,	2.8)
	•	•
strip 2 ,		
5 CHRIS 2, 1962	(0.1,	
6 CARROW, 1933	(0.0,	0.8)
7 DELAWARE (USE) 1932	(0.3,	1.0)
8 BOMBAY (USE) 1933	(0.2,	0.5)
		-
strip 3		
14 FAIRVIEW, 1933	(0.3,	0.9)
13 STAND RM1, 1933	(0.2,	0.8)
12 PALMYRA RIVERTON-PALMYRA WATE	R	
CO. STANDPIPE, 1933	(1.7,	1.8)
11 PHILA NAVY YARD POWER PLANT		
WATER TANK, 1933	(1.5,	1.4)
10 GIBBSTOWN MUNICIPAL	•	
WATER TANK, 1933	(1.3,	0.9)
9 DEPOT, 1933	(2.2,	
5 CHRIS 2, 1962	(0.6,	
	•	
strip 4		
16 GOAT HILL, 1876	(0.0,	0.0)
15 YARDLEY MUNICIPAL		
STANDPIPE, 1933	(0.0,	0.0)
14 FAIRVIEW, 1933	(0.0,	0.0)

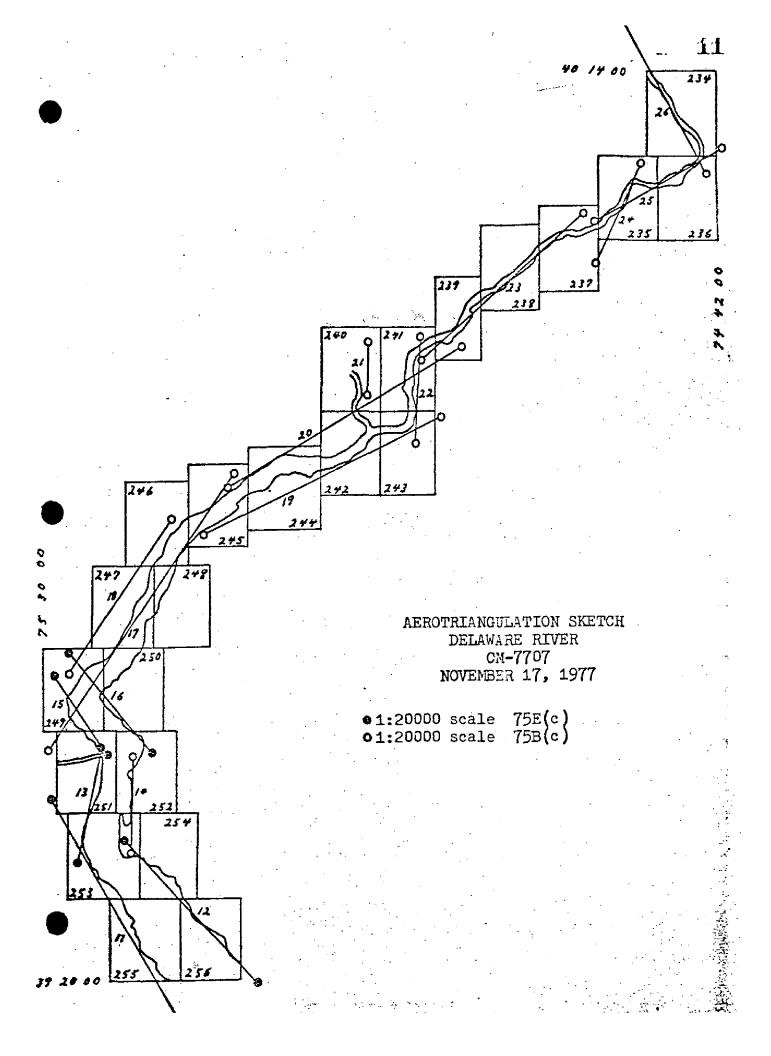

INDEX TO 1:20,000 PHOTOGRAPHS DELAWARE RIVER CM-7707

STRIP 11 STRIP 12A STRIP 12B STRIP 13 STRIP 14 STRIP 15 STRIP 16A STRIP 16B	75E(C) 75E(C) 75E(C) 75E(C) 75E(C) 75E(C) 75E(C) 75E(C)	8674-8691 8713-8721 8722-8725 8777-8784 4730-4736 8735-8741 8746-8751 8753-8755
STRIP 17A STRIP 17B	75B(C) 75B(C)	4742-4745 4746-4763
STRIP 18	75B(C)	4772-4784
STRIP 19A STRIP 19B	75B(C) 75B(C)	4792-4795 4797-4809
STRIP 20A STRIP 20B	7 <i>5</i> B(C) 7 <i>5</i> B(C)	4812-4814 4818-4830
STRIP 21	75B(C)	4843-4846
STRIP 22	75B(C)	4879-4882
STRIP 23	75B(C)	4894-4907
STRIP 24A STRIP 24B	75B(C) 75B(C)	4942-4944 4946-4948
STRIP 25	75B(C)	4911-4920
STRIP 26	75B(C)	4925-4937

Photogrammetric Plot Report
Delaware River
Arnold Point to Trenton, Delaware, New Jersey
Job CM-78057508
October 15, 1976

21. Area Covered

This report covers Delaware River from Arnold Point to Trenton, Delaware, New Jersey.

22. Method

Nineteen strips of photography were bridged by analytic aerotriangulation methods and adjusted to ground on the New Jersey State Plane Coordinate System. Four strips of 1:60,000 photography were bridged to establish control for the bridging of 1:20,000 photography. Fifteen strips of 1:20,000 were bridged to determine positions of field identified landmarks, aids to navigation, and supplemental objects. This data was processed on 76-40 forms. Overlay sheets of these positions were plotted on the Coradomat using the same scale of published nautical charts, 12311 (C&GS 294), 12312 (C&GS 295), 12313 (C&GS 280) and inset, 12314 (C&GS 296), and 12277 (C&GS 570) eastern half only, west to longitude 38'.

Overlay sheets, 76-40 forms, and output cards of the 76-40 program were forwarded to the Special Projects Section for final preparation, which on compilation will be routed to the Marine Chart Division.

completion

23. Adequacy of Control

The horizontal control provided was adequate except for Navy, 1925 paneled station which did not hold in the adjustment. No apparent reason was determined and the station was dropped from the adjustment.

24. Supplemental Data

Local shoreline and U.S. Geological Survey quadrangles were used to provide elevations for vertical adjustments of bridges.

25. Photography

RC-8 and RC-10 color positives were adequate as to coverage, overlay, and definition.

Submitted by:

R R Kelly

Approved and Forwarded:


J. D. Penrow, Jr.



5682 Q A16

AEROTRIANGULATION SKETCH DELAWARE RIVER CM-7508 OCTOBER, 1976

o 1:60000 scale 75C color

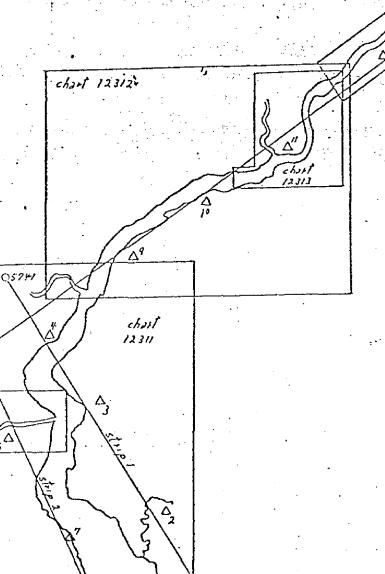

5715

5712 0


chart 12277

fit to control (feet)

			11 - 1 - 14 - 14 - 14 - 14 - 14 - 14 -
strip 1		•	
1 WELLS,1975			. 0.3)
2 WILLIS, 1933			0.5)
3 SALEM, 1933	()	0.9,	1.5)
4 NEW CASTLE BELIANCA AIRPORT			
SQUAT W.T., 1933			4.5)
5 CHRIS 2, 1962	. (:	0.8,	2.8)
·····································		ا المحمد المحمد المحم	
strip 2			
5 CHRIS 2, 1962	(0.1,	0.3)
6 CARROW, 1933			. 0.8) §
7 DELAWARE (USE) 1932	(0.3,	1.0)
8 BOMBAY (USE) 1933	(0.2,	0.5)
		::	
strip 3			
14 FAIRVIEW, 1933			0.9)
13 STAND RM1, 1933	(0.2,	0.8)
12 PALMYRA RIVERTON-PALMYRA WAT	ER		
CO. STANDPIPE, 1933	()	1.7,	1.8)
11 PHILA NAVY YARD POWER PLANT			
WATER TANK, 1933	. (:	1.5,	1.4)
10 GIBBSTOWN MUNICIPAL	٠.		
WATER TANK, 1933	(:	1.3,	0.9)
9 DEPOT, 1933	(2.2,	0.3)
5 CHRIS 2, 1962	(0.6,	0.2)
strip 4			
16 GOAT HILL, 1876	• (0.0,	0.0)
15 YARDLEY MUNICIPAL	-		
STANDPIPE, 1933			0.0)
14 FAIRVIEW, 1933	(0.0,	0.0)

AEROTRIANGULATION SKETCH
DELAWARE RIVER
CM-7508
OCTOBER, 1976

01:20000 scale 75E color 01:20000 scale 75B color

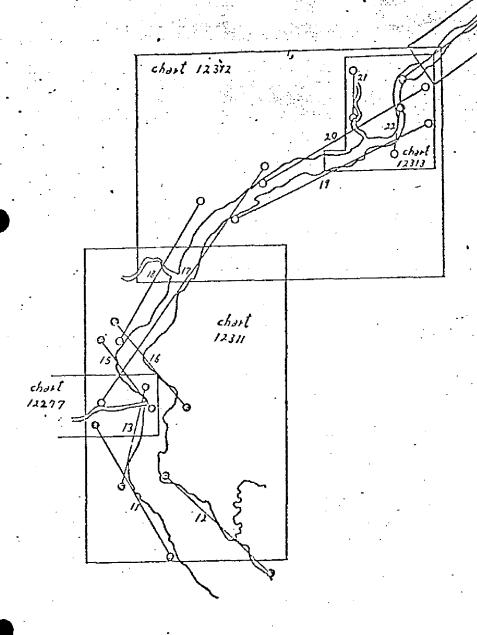

1

INDEX TO 1:20,000 PHOTOGRAPHS DELAWARE RIVER CM-7508

STRIP 11A 75E(C) 8679-8681

" 11B 75E(C) 8684-8686

" 11C 75E(C) 8689-8691

STRIP 12A 75E(C) 8713-8715

" 12B 75E(C) 8719-8721

" 12C 75E(C) 8722-8725

STRIP 13 75E(C) 8777-8784

STRIP 15 75E(C) 8735-8741

STRIP 16A 75E(C) 8746-8748

16B 75E(C) 8753-8755

STRIP 17A 75B(C) 4742-4745

17B 75B(C) 4746-4763

STRIP 18 75B(C) 4772-4784

STRIP 19A 75B(C) 4792-4795

" 19B 75B(C) 4797-4809

STRIP 20A 75B(C) 4812-4814

" 20B 75B(C) 4818-4830

STRIP 21 75B(C) 4843-4846

STRIP 22 75B(C) 4879-48821 --

STRIP 23 75B(C) 4894-4907

STRIP 24A 75B(C) 4942-4944

24B 75B(C) 4946-4948

STRIP 25 75B(G) 4911-4920

STRIP 26 75E(C) 4925-4937

U.S. DEPARTMENT OF COMMERCE NATIONAL OCEANIC AND ATMOSPHERIC ADMINISTRATION 927 Coostal Mapping Div. (Rockwille) GEOGRAPHIC POSITION REMARKS 127 DATE DATE DATE ORIGINATING ACTIVITY 39-34-36.36 75-28-38. A LONGITUDE \$\phi\$ LATITUDE 1 SUPERSEDES NOAA FORM 76-41, 2-71 EDITION WHICH IS OBSOLETE. ٠ 1927 DESCRIPTIVE REPORT CONTROL RECORD 0 ~ • ~ ⊕. ~ • \prec -өφ. ~ Φ. ~ ♣ ~ Φ. -0-~ MWC Worth American COORDINATES IN FEET HAND PLOTTING CHECKED BY COMPUTATION CHECKED BY LISTING CHECKED BY GEODETIC DATUM STATE ZONE Ħ μ, £ ž 3 ħ, ¥ ۲ ı, Ä 2 ۳ Ę ž 'n 취 g E ž £ PATRITIE AEROTRI-ANGULATION POINT NUMBER DATE CM-7707 12/9 74 SOURCE OF INFORMATION (Index) 0 1 ON BOL 11.3 6.0 1933 STATION NAME 77-0025 HAND PLOTTING BY Salem NOAA FORM 76-41 (6-75) COMPUTED BY LISTED BY MAP NO

Compilation Report TP-00252

Field and Aerotriangulation work used to complete this map was performed under Job CM-7508 (Del, River). Field cerations consisted of aerial photography, premarking of control, and the location or photoidentifying of landmarks and aids. During bridging operations positions were determined for the field identified objects and those located by photogrammetric field mehtods. A duplicate copy of the Photogrammetric Plot Report for Job CM-7508 is bound with this Descriptive Report. Field records and reports are on file in the National Archives under CM-7508.

31. Delineation

This map was compiled on the Wild B-8 steroplotter using 1:20,000 scale natural color photography taken in 1975.

32. Control

Refer to the Photogrammetric Plot Reports bound with this Descriptive Report.

The indentification, density, and placement of horizontal and vertical control was adequate.

- 33. Supplemental Data None
- 34. Contours and Drainage

All draingage is from office interpretation of the color photography.

35. Shoreline and Alongshore Detail

The mean high line was compiled by office interpretation of the color photography. No mean low water was compiled for this map.

Alongshore and foreshore features were delineated by office interpretation of the same photography.

There was no preliminary field inspection of the shoreline,

36. Offshore Detail

No unusual problems were encountered in compiling details offshore.

37. Landmarks and Aids

Positions of landmarks and nonfloating aids were determined under Job CM-7508. Refer to the Photogrammetric Plot Report (CM-7508) submitted with this Descriptive Report.

Landmarks were Field inspected to determine their values,

Refer to the 76-40 listings prepared for the date and method of location of each object.

38. Control for Future Surveys

No Form 524 was submitted.

39. Junctions

Refer to Form 76-36B, Item 5, of the Descriptive Report.

- 40. Horizontal and Vertical Accuracy No comment
- 41. thru 45. Inapplicable
- 46. Comparison with Existing Maps

A comparison was made with the following USGS quadrangles:

Delaware City, Del.-N.J., 1:24,000 scale, 1948 Edition photo revised:1970.

Salem, N.J., 1:24,000 scale, 1953 Edition photo revised 1970.

No significant differences were noted.

47. Comparison with Nautical Charts

A comparison was made with the following chart:

12311 (formerly C&GS 294), 1:40,000 scale, 26th Edition dated 7/30/77

Items to be Applied to Nautical Charts immediately - None Items to be Carried Forward - None

L. Harrod

Approved_and Forwarded:

George M. Ball Chief, Special Projects Section

Final Review Report CM-7707

Shoreline Survey TP-00252

61. General Statement

Field edit was canceled November 1978 consequently this map is registered as Class III. All landmarks and aids were located in the field for Job CM-7508 which covers this same area. The compilation for that project was canceled December 1975, and all landmarks and aid information has been applied to this project.

The forms 76-40 are not furnished to charts with this job. Duplicate forms were furnished April 1977, with Job CM-7508.

- 62. thru 64. Inapplicable
- 65. Comparison with Nautical Charts

This map was compared with the following:

Chart 12311, Pub. July 1977, 26th Edition - 1:40,000 scale

66. Adequacy of Results and Future Surveys

This map meets the National Standards of Map Accuracy and complies with Bureau requirements.

Submitted by,

F. R. Watts

Approved and Forwarded:

Chief, Photogrammetric Branch

Chief, Photogrammetry Division

GEOGRAPHIC NAMES

FINAL NAME SHEET

CM-7707 (Delaware River, Del., N.J.)

TP-00252

Alloway Creek

Artificial Island

Baldridge Creek

Black Ditch

Delaware River

Eagle Island

Elsinboro Point

Fort Elfsborg

Hickory Island

Mill Creek

Mill Creek Cove

Money Island

Oakwood Beach (P pl)

Salem

Salem Cove

Salem River

Sinnickson Landing

Straight Ditch

Prepared by:

Charles E. Harrington

Chief Geographer

·HEL	OF 2 ACTIV	DMA	* CHARTS * *		* *	* * 123	* + 12311	* * * * * * * * * * * * * * * * * * * *	* * *	* * * i	* *	* * * ! ! ! ! ! ! !	* * *	**
NOAA	* PAGE * PAGE *ORIGINATI	R VALUE A	ETHOD AND DATE OF LOCATION FICE * FIELD		* *	* P=5 * 7/15/7	* 7/15/7)4734* 8/75 *	* *	* *	* *	! ! ! ! ! ! ! ! ! ! ! ! ! ! ! ! ! ! !	* *	**
AN SURVEY OF COMMERCE	D ROCKVI W JERSEY LAWARE R	DETERMINE	CMD * ME ALTEK* DGTZD* OFF	1		5 NO 6 DGT	2 NO 9 DGT	382.1 NOT *75B(C 642.7 DGTZD* 08/2	* *	* *	* *	* *	* *	* *
TIONAL OC	UNIT STATE ALITY DATE	D FROM SEAWA	POSITION LATITUDE DM LONGIŢŪDE DP			34 15.29 47 31 03.63 8	34 41.09 1	50 12.39 32 27.03	10 10 10 10 10 10 10 10 10 10 10 10 10 1	3 3 3 4 3 4				
BRA	IDS FOR CHARTS REVISED	EEN INSPECT	ETION **		I		* *	CK * 39	* *			* *	* *	* *
PHOTOGRAMM COASTAL MAP	NONFLO	HAVE NO	DESCRIPTION RD REASON FOR D IANGULATION NAM		NIVER ENTRANCE			SLAN						
-40 NIT	TP-00252 CM-7707 DEL. RIVER NA 1927	FOLLOWING	ARTING* NAME * PU		* 0466	RANGE * F LT *	* *	R * REEDY T * LIGHT	* *	* *	* *	* *	* *	* *

TYPE	TYPE OF ACTIOM	¥	MAMES OF RESPONSIBLE PERSONNEL	*	ORIGINATOR
	, (1 1 1 1 1 1 1			
		*		*	
		*		*	
		*		*	
POSITIONS	POSITIONS DETERMINED	*	R. TIBBETTS R. WELLS	*	FIFI REPRESENTATIVE
ANIDZOR V	ANDZOR VERIFIED BY	*	D. MORMAN G. FROWN	*	OFFICE COMPILED
FIELD A	FIELD AND OFFICE	*	ILISIC TON	*	
VCTI	ACTIVITIES	*	S. FROMW	*	DATA PROCESSER

ERS 770	OF 2 ATION	ANDMA	* * CHARTS * *AFFECTED*	12311	* * 7 7 7 1 1 1 1 1 1 1 1 1 1 1 1 1 1 1 1 1	24		ATOR	D PARTY *	ENTATIVE ,
	PAGE ORIGINATIN COMPI	VALUE AS	D AND DATE LOCATION * FIELD	F-3-6-					 	**************************************	• • • • • • • • • • • • • • • • • • •	1	 		ORIGIN	FIEL	IELD REPRESE
NOAA	 • •	THEI	METHO OF OFFICE				† 		 			 				 * *	* * *
SURVEY COMMER	OCKVILLE ERSEY ARE RIVE	DETERMIN	CM0 * ALTEK* DGT2D*		* *	* * * * * 				1		 	† † * * * * * * 		ONNEL	•	φ
OCEA ENT O	I D Z D O	ARD T	NO 1	862.6		 		1 1 1					[] 		E, PERS	RTY	FROMM
PAR	* RPT UNI * STAT * LOCALIT	TED FROM SE	. ,	39 34 27.97 75 28 24.07							1 1 1 1 1 1 1 1 1 1 1 1 1 1 1 1 1 1 1	} } 	} } 	1 , , , , , , , , , , , , , , , , , , ,	SPONSI	HOTO FIELD	. TIBBETTS R . NORMAN G.
ANCHISION		INSPEC	* * * *	* *	* *	* * *	; * *	; * *	* * *	* *	! ! * *. !	; ! * * !	! ! ! * *	1 1	NAMES	<u>a</u>	α _O
DIV	OR CHAI	BEEN	ELETION ES IN (TANK		1			; ; ; ;	; ; ; ; ;	;] [[[]	; 	; 1 1 1		· Z. · · · · · · · · · · · · · · · · · ·	 - * *	* * .*
SRAMME MAPP	ARKS O BE	Æ	1 2 4 1 12 4 1	19	 	 	1	; 		 	! ! !	, 	l l	1		SEAWARD	
PHOTO OASTA	L A N D	JECTS	ECORD REASON FOR	NICIPAL.	! ! ! !	1 1 1 1 1 1 1 1 1 1 1 1 1 1 1 1 1 1 1 1	 		! 1 1 1 1 1 5		1 1 1 1 1 1	 			CTION	FROM	ERMINED IED BY
	2552	MING OBJE	. x .) 	! ! ! !	1 1 į	# # # # # # # # # # # # # # # # # # #	PE OF A	SPECTED	POSITIONS DETERMINED AND/OR VERIFIED BY
• Z	DE NA	FOLL	 * * * B I I I I I I I I I		! ! * * !	 	1 1 1 * * 1	1 1 1 * * 1	 	! : ! * *	 * * -	 	1		- 	CTS	POSITI AND/0
76- LIST		I	**************************************	+ 	! ! ! !	 	 - - 	1 	 	; * * * ·	: 	; ! ! ! ! !	• • • • •		t	0B	* * *

CM-7707

Delaware River

TP-Sheets 00246 thru 00256

NATIONAL ARCHIVES

18 76-41 Forms

Bridging Printouts

List of triangulation stations reported on NOAA Forms 76-96

List of USGS Quad Coverage

" " Chart Coverage

Tide Data

11 Sets (1 set for each map) 76-40 Forms
2 Project Diagrams with flight lines indicated
 Compilation Report

Index to 1:60,000 Photos

Delaware River

CM-7707 NATIL ARCHINES

Strip 1	75C(C) 57	29-5743
Strip 2	75C(C) 57	15-5724
Strip 3	750(C) 56	91-5713
Strip 4	75C(C) 56	82_5680

INDEX TO 1:20,000 PHOTOGRAPHS DELAWARE RIVER CM-7707

NATIONAL ARCHIVES

STRIP STRIP STRIP STRIP STRIP STRIP STRIP STRIP	11 12A 12B 13 14 15 16A 16B	75E(C) 75E(C) 75E(C) 75E(C) 75B(C) 75E(C) 75E(C) 75E(C)	8674-8691 8713-8721 8722-8725 8777-8784 4730-4736 8735-8741 8746-8751 8753-8755
STRIP	17A 17B	75B(C) 75B(C)	4742-4745 4746-4763
STRIP	18	75B(C)	4772-4784
STRIP STRIP	19A 19B	75B(C) 75B(C)	4792-4795 4797-4809
STRIP STRIP	20A 20B	75B(C) 75B(C)	4812-4814 4818-4830
STRIP	21	75B(C)	4843-4846
STRIP	22	75B(C)	4879-48826
STRIP	23	75B(C)	4894-4907
STRIP STRIP	24A 24B	75B(C) 75B(C)	4942-4944 4946-4948
STRIP	25	75B(C)	4911-4920
STRIP	26	75B(C)	4925-4937

CM-7508

Delaware River

82 76-40 Forms

1 Control Diagram

6 Charts (Field annotated) 12304, 12311, 12277, 12312, 12313, and 12314

Computer printouts

16 C&GS 738 Forms

19 C&GS 155 Forms

1 Photogrammetric Plot Report

12 76-36C Forms

15 76-72 Forms

410 76-53 Forms

21 76-41 Forms

104 76-40 (Field Copy)

1 Bridging Printout

227 76-96 Forms

Field Inspection Photos:

75E(C) 8755

75E(C) 8672-8691

75E(C) 8710-8729

75E(C) 8774-8785

75B(C) 4729-4738

75E(C) 8730-8742

75E(C) 8743-8754

75B(C) 4739-4763

75B(C) 4764-4786

75B(C) 4787-4811

75B(C) 4812-4838

75B(C) 4839-4849

75B(C) 4878-4888

75B(C) 4894-4910

75B(C) 4911-4921

75B(C) 4922-4937

NAUTICAL CHART DIVISION

RECORD OF APPLICATION TO CHARTS

FILE WITH DESCRIPTIVE REPORT OF SURVE	Y NO
---------------------------------------	------

INSTRUCTIONS

A basic hydrographic or topographic survey supersedes all information of like nature on the uncorrected chart.

1. Letter all information.

2. In "Remarks" column cross out words that do not apply.

3. Give reasons for deviations, if any, from recommendations made under "Comparison with Charts" in the Revic

CHART	DATE	10 CCARTOGRAPHER	REMARKS
12311	10-22-79	DC HARPINE	Full Part Before After Verification Review Inspection Signed Via
			Drawing No. 48
·- 	<u> </u>		Full Part Before After Verification Review Inspection Signed Via
···	 	<u>-</u>	Drawing No.
			214.116
			Full Part Before After Verification Review Inspection Signed Via
			Drawing No.
<u>. </u>	<u>]</u>	<u> </u>	Full Part Before After Verification Review Inspection Signed Vis
			Drawing No.
	1		Full Dan Def. Africa V. 16.
			Full Part Before After Verification Review Inspection Signed Via Drawing No.
			Diaming No.
			Full Part Before After Verification Review Inspection Signed Vi
			Drawing No.
<u>-</u>	-		Full Part Before After Verification Review Inspection Signed Vi
			Drawing No.
			Full Part Before After Verification Review Inspection Signed Vis
			Drawing No.
	<u> </u>		
·			Full Part Before After Verification Review Inspection Signed Viz
			Drawing No.
	<u>. </u>	<u> </u>	Full Part Before After Verification Review Inspection Signed Vi-
		-	Drawing No.